

Stone Forge Commissary

255 WALNUT STREET
WEST BRIDGEWATER, MA

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ABBREVIATIONS

AC.F.	ACOUSTICAL CEILING	M.R.&W.B.	MOISTURE RESISTANT GYP. WALLBOARD
ACCESS.	PANEL ACCESSORIES	M.S.B.C.	MASSACHUSETTS STATE BUILDING CODE
ADJ.	ADJACENT	MTG.	MOUNTING
ADDNL.	ADDITIONAL	N.T.L.	NORTH
AFF.	ABOVE FINISHED FLOOR	N.I.C.	NOT IN CONTRACT
AFC.	ABOVE FINISHED CEILING	N.O.	NUMBER
ALUM.	ALUMINUM	NT.S.	NOT TO SCALE
ANT.	ANTENNA	O.A.	OVERALL
APPROX.	APPROXIMATELY	O.C.	ON CENTER
ARCH.	ARCHITECTURAL	O.C.H.	ON CENTER HORIZONTALLY
AVG.	AVERAGE	O.C.V.	ON CENTER VERTICALLY
BLDG.	BUILDING	O.D.	OUTSIDE DIAMETER
BLKG.	BLOCKING	O.F.I.	OWNER FURNISHED & INSTALLED
B.O.	BOTTOM OF	O.F.G.I.	OWNER FURNISHED & CONTRACTOR INSTALLED
BOT.	BOTTOM	O.H.D.	OVERHEAD DOOR
C.F.T.	CERAMIC FLOOR TILE	O.H.F.	OFFSHORE
C.J.	CONTROL JOINT	O.O.P.	ORIGINAL
CLG.	CEILING	O.R.G.	ORIGINAL
CLR.	CLEARANCE	P.L.A.M.	PLASTIC LAMINATE CONST. PATCH & REPAIR
C.M.U.	CONCRETE MASONRY UNIT	F. & R.	FREPREP / PREPARATION
COL.	COLUMN	P.C.	POLYSTYRENE
CNC.	CONCRETE	P.F.	PER SQUARE FOOT
CONT.	CONTINUOUS	P.F.I.	PER SQUARE INCH
CONTR.	CONTRACTOR	P.T.D.	PAINTED
COVR.	CORRIDOR	R.B.	RUBBER BASE
CPT.	CARPET	R.C.P.	REFLECTED CEILING PLAN
C.R.	CHAIR RAIL	R.D.	ROOT DRAIN
C.R.S.	COURSE	REF.	REFERENCE
CT.	CERAMIC TILE	REIN.	REINFORCED
C.T.C.B.	CERAMIC TILE COVE BASE	R.F.T.	REQUIRED
CTR.	COUNTER	REQ'S	REQUIREMENT(S)
CUT.	CERAMIC WALL TILE	REV.	REVISION
D/B.	DESIGN/BUILD	RFL.	REFLECT
DEMO.	DEMOLITION	R.T.U.	ROOM TOP UNIT
DET.	DETAIL	S.	SOUTH
DIAG.	DIAGONAL	SCHED.	SCHEDULE
DIM.	DIMENSION	SCHUD.	SOLID CORE WOOD DOOR
DIMS.	DIMENSIONS	SECT.	SECTION
D.O.	DOOR OPENING	SIM.	SIMILAR
DWG.	DRAWING	SPEC.	SPECIFICATION
E.	ELECTRICAL	S.L.D.R.	SOLDIER
ELEV.	ELEVATION	S.S.	STAINLESS STEEL
EQUIP.	EQUIPMENT	STD.	STANDARD
EXIST.	EXISTING	STR.	STEEL
EXP.	EXPOSED	STRFR.	ALUM. STOREFRONT
EXT.	EXTERIOR	STRUCT.	STRUCTURAL
FAB.	FABRICATED	SUSP.	SUSPENDED
F.D.	FLOOR DRAIN	SYST.	SYSTEM
F.E.C.	FIRE EXTINGUISHER	T.	TREAD
FIN.	CABINET FINISH	T.B.B.	TILE BACKER BOARD
FL.	FLOOR	TEL.	TELEPHONE
FLUOR.	FLUORESCENT	TEMP.	TEMPERED
FOUN.	FOUNDATION	THRU.	THROUGH
FORM.	FACE OF MASONRY	T.M.E.	TO MATCH EXISTING
FRTW.	FIRE-TREATED WOOD	T.O.F.	TOP OF TYPICAL
FT.	FOOT	U.	UNDERWRITER'S LABORATORY
FTG.	FIELD WELL	UNO.	UNLESS OTHERWISE NOTED
F.W.	FABRIC WALL COVERING	U.S.G.	UNITED STATES GYPSUM
G.A.	GAUGE	V.C.T.	VERY HIGH IMPACT (GWB)
GALV.	GALVANIZED	VERT.	VERIFY IN FIELD
G.C.	GENERAL CONTRACTOR	V.F.	VINYL STRAIGHT BASE
GLASS	GLASS	V.V.C.	VINYL WALL COVERING
GWB.	GYPSUM WALL BOARD	W.	WEST
GYP.	GYPSUM	W/O	WITH OUT
H.C.	HOLLOW CORE	W/O	WITH OUT WOOD
HGT.	HEIGHT	WHSE.	WAREHOUSE
H.J.R.	HORIZONTAL JOINT REINF.	W.M.P.	WALK-OFF MAT
HORIZ.	HORIZONTAL	W.W.P.	WELODED WIRE FABRIC
H.P.	HIGH POINT	W.W.P.	WELODED WIRE MESH
H.P.L.	HIGH PRESSURE LAMINATE	W.W.P.	WELODED WIRE MESH
IN.	INFORMATION	W.W.P.	WELODED WIRE MESH
INFO.	INFORMATION	W.W.P.	WELODED WIRE MESH
INSUL.	INSULATION	W.W.P.	WELODED WIRE MESH
LAV.	LAVATORY	W.W.P.	WELODED WIRE MESH
MAL.	MATERIAL	W.W.P.	WELODED WIRE MESH
MAX.	MAXIMUM	W.W.P.	WELODED WIRE MESH
MECH.	MECHANICAL	W.W.P.	WELODED WIRE MESH
M.E.C.	MECHANICAL, ELEC. PLUMB.	W.W.P.	WELODED WIRE MESH
MFR.	MANUFACTURER	W.W.P.	WELODED WIRE MESH
MIN.	MINIMUM	W.W.P.	WELODED WIRE MESH
MISC.	MISCELLANEOUS	W.W.P.	WELODED WIRE MESH
M.O.	MASONRY OPENING	W.W.P.	WELODED WIRE MESH

DESIGN/BUILD NOTES

1) THE GENERAL CONTRACTOR (G.C.) SHALL FIELD-VERIFY ALL DIMENSIONS & CONDITIONS PRIOR TO THE WORK AND SHALL IMMEDIATELY NOTIFY THE ARCHITECT REGARDING ANY DISCREPANCIES.

2) THE G.C. AND THE DESIGN/BUILD (D/B) SUBCONTRACTORS SHALL BE RESPONSIBLE FOR PROVIDING COMPLETE D/B PLUMBING, FIRE PROTECTION, HVAC, AV SYSTEMS, SMOKE & HEAT DETECTORS, ELECTRICAL DESIGN AND LAYOUT DRAWINGS WITH CALCULATIONS & LOADS WHICH CONFORM TO ALL STATE AND LOCAL CODES, STAMPED AND CERTIFIED (EXCEPT FOR CERTAIN LICENSED PROFESSIONALS PER M.G.L. C.12B.01R) BY A REGISTERED P.E. AS REQUIRED BY THE TOWN OF WEST BRIDGEWATER BUILDING & FIRE DEPTS. AT THE TIME OF PERMIT. THIS INCLUDES ANY ENERGY CONSERVATION DATA AND NARRATIVE AS REQUIRED PER CHAPTER 13 OF THE MASSACHUSETTS STATE BUILDING CODE (M.S.B.C.) SIXTH EDITION AS AMENDED.

3) THE G.C. SHALL SEAL ALL THROUGH-WALL & FLOOR PENETRATIONS WITH 3M BARRIER CAULK AND SEALANT ON U.S.G. SAFING & G.W.B. PARTITIONS AND 2500 PSI GROUT & MASONRY WALLS. INSTALL ANY REQUIRED FIRE RATED PARTITIONS TO UNDERSIDE OF ROOF DECK UNO.

4) THE G.C. SHALL BE RESPONSIBLE FOR DAILY REMOVAL AND LEGAL DISPOSAL OF ALL DEBRIS.

5) THE G.C. SHALL BE RESPONSIBLE FOR ALL PERMITS AND FEES AS REQUIRED BY THE TOWN OF WEST BRIDGEWATER.

7) THE DRAWINGS ARE NOT TO BE SCALED. ALL WORK, LINES AND LEVELS SHALL BE LAID OUT BY WRITTEN DIMENSIONS. G.W.B. DIMENSIONS ARE FROM FACE TO FACE OF FINISH. ANY DEVIATIONS SHALL BE BROUGHT TO THE ATTENTION OF THE ARCHITECT IMMEDIATELY. ALL DEVIATIONS SHALL BE CORRECTED BY THE CONTRACTOR BEFORE HE BEGINS HIS PORTION OF THE WORK.

8) INSTALL A CONTINUOUS SEALANT BEAD ON BACKER ROD AT ALL JUNCTURES OF DISSIMILAR MATERIALS (E.G. METAL TO CMU, STEEL TO ALUMINUM) AND ALL MATERIAL JOINTS AS REQUIRED BY THE MANUFACTURER'S SPECIFICATIONS AND RECOMMENDATIONS, INDUSTRY STANDARDS AND GOOD PRACTICE.

9) COORDINATE SOLID FRUW BLOCKING FOR ALL WALL MOUNTED EQUIPMENT AND ACCESSORIES.

10) PROVIDE CONTINUOUS GALVANIZED METAL EDGE TRIM AT ALL G.W.B. WORK.

11) THE G.C. SHALL SUBMIT ALL SHOP DRAWINGS, SAMPLES, CATALOG CUTS ETC. INCLUDING COLOR CHARTS FOR PAINTS AND STAINS FOR ALL EXTERIOR AND INTERIOR FINISHES, TO THE ARCHITECT FOR SELECTION, REVIEW AND APPROVAL PRIOR TO ORDERING, FABRICATION, OR INSTALLATION.

12) THE G.C. SHALL INSTALL ALL INTERIOR FINISHES AT ALL SURFACES INDICATED ON THE DRAWINGS IN CONFORMANCE TO M.S.B.C. TABLE 803.4. ALL DOORS SHALL HAVE LEVER HARDWARE TO CONFORM TO ADAAG.

13) INSTALL U.S.G. 033 (OR APPROVED EQUAL) CONTROL JOINTS @ 3'-0" O.C. MAX. OR AS PER MANUFACTURER'S SUGGESTED DETAILS AND SPECIFICATIONS.

14) PERFORM ALL WORK IN ACCORDANCE WITH THE M.S.B.C. AND ADAAG, AS WELL AS ALL MUNICIPAL BYLAWS AND ORDINANCES.

15) THE G.C. SHALL BE RESPONSIBLE FOR D/B SUBCONTRACTOR'S CONFORMANCE TO M.S.B.C. CHAPTER 16 REQUIREMENTS FOR MECHANICAL AND ELECTRICAL SYSTEM AND COMPONENT SEISMIC PERFORMANCE. REFER TO TABLES 1612.1.4(1) AND 1612.1.4(2) FOR CRITERIA FACTORS AND APPLICABILITY.

MECHANICAL NOTES

1) THE PLUMBING SUBCONTRACTOR SHALL BE RESPONSIBLE FOR THE DESIGN, ENGINEERING, LAYOUT, CALCULATIONS, COORDINATION AND COMPLIANCE TO THE MASS. STATE FUEL GAS & PLUMBING CODE (CMR 248), AS WELL AS TOWN OF WEST BRIDGEWATER PLUMBING INSPECTOR'S PROTOCOL, FOR ALL WORK.

2) THE D/B HVAC SUBCONTRACTOR SHALL PROVIDE SURETY, RETURN MAKE-UP AIR, EXHAUST SYSTEMS & CONTROL, WIRING, DEVICES & EQUIP. AS REQUIRED BY THE LATEST EDITION OF THE BOCA MECHANICAL CODE AND M.S.B.C. CHAPTER 13 FOR ENERGY CONSERVATION WORK SHALL CONFORM TO SHACMA & ASHRAE STANDARDS, PROVIDE NARRATIVE AS PER M.S.B.C. CH. 13.

3) PROVIDE EMERGENCY LIGHTING, EXIT SIGNS AND EXIT LIGHTS AS PER M.S.B.C. SECTION 1073.0 & 1074.0.

4) THE G.C. AND D/B ELECTRICAL SUBCONTRACTOR SHALL REVIEW LIGHT FIXTURE SPECIFICATIONS WITH ARCHITECT AND OWNER PRIOR TO THE WORK.

5) THE D/B ELECTRICAL SUBCONTRACTOR SHALL BE RESPONSIBLE FOR CONFORMING TO NEC & MEC LATEST EDITIONS FOR ALL ELECTRICAL WORK.

6) CONFORM TO M.S.B.C. NFPA 70 & ADAAG MOUNTING HEIGHTS OF ALL DEVICES AND FIRE ALARM SYSTEM COMPONENTS.

General Notes:

1) THE GENERAL CONTRACTOR SHALL CONFORM TO AIA DOCUMENT (1987) GENERAL CONDITIONS.

2) FINISH FLOOR SLAB ELEVATION ASSUMED TO BE 100'-0" FOR THIS PROJECT.

3) FIRE EXTINGUISHER AND CABINET QUANTITIES AND LOCATIONS TO BE COORDINATED WITH THE TOWN OF WEST BRIDGEWATER FIRE DEPARTMENT PRIOR TO ORDERING AND INSTALLATION. CONFORM TO 521 CMR FIRE REGS. AND NFPA-10.

4) THE GENERAL CONTRACTOR (G.C.) SHALL FIELD VERIFY ALL DIMENSIONS & CONDITIONS PRIOR TO THE WORK AND SHALL NOTIFY THE ARCHITECT REGARDING ANY DISCREPANCIES.

5) THE G.C. SHALL SUBMIT ALL SHOP DRAWINGS, SAMPLES, CATALOG CUTS ETC. INCLUDING COLOR CHARTS FOR PAINTS AND STAINS FOR ALL FINISHES, TO THE ARCHITECT FOR SELECTION, REVIEW AND APPROVAL PRIOR TO FABRICATION OR INSTALLATION.

6) THE G.C. SHALL COORDINATE THE WORK OF ALL TRADES REGARDING CEILING-MOUNTED AND ABOVE-CEILING-MOUNTED EQUIPMENT, DEVICES AND FIXTURES.

7) PERFORM ALL WORK IN ACCORDANCE WITH THE M.S.B.C., M.A.A.B., AND ADAAG, AS WELL AS ALL LOCAL CODES AND ORDINANCES.

8) THE G.C. SHALL BE RESPONSIBLE FOR ALL PERMITS, BACKCHARGES AND FEES AS REQUIRED BY THE TOWN OF WEST BRIDGEWATER.

9) THE G.C. SHALL BE RESPONSIBLE FOR DAILY REMOVAL AND LEGAL DISPOSAL OF ALL DEBRIS OFF SITE.

10) THE G.C. SHALL SEAL ALL THROUGH-WALL & FLOOR PENETRATIONS WITH 3M BARRIER CAULK (O.A.E.) AND SEALANT ON U.S.G. SAFING 2500 PSI GROUT. INSTALL ANY REQUIRED FIRE RATED PARTITIONS TO UNDERSIDE OF FLOOR AND ROOF DECK, INCLUDING DEFLECTION HEAD FIRE SAFING.

11) COORDINATE SOLID BLOCKING FOR ALL WALL AND CEILING MOUNTED EQUIPMENT AND ACCESSORIES.

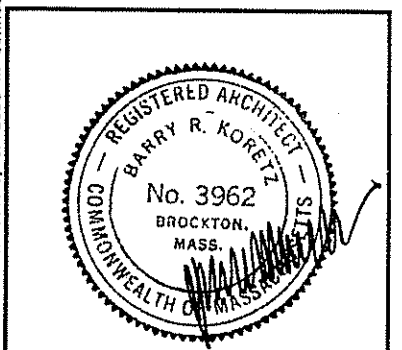
12) PROVIDE CONTINUOUS GALVANIZED METAL EDGE TRIM AT ALL G.W.B. WORK.

13) THE G.C. SHALL INSTALL ALL INTERIOR FINISHES AT ALL SURFACES INDICATED ON THE DRAWINGS IN CONFORMANCE TO M.S.B.C. TABLE 803.4. ALL DOORS SHALL HAVE LEVER HARDWARE TO CONFORM TO M.A.A.B. AND ADAAG RULES AND REGULATIONS.

14) INSTALL U.S.G. 033 (OR APPROVED EQUAL) CONTROL JOINTS @ 3'-0" O.C. MAX. OR AS PER MANUFACTURER'S SUGGESTED DETAILS AND SPECIFICATIONS.

PROJECT DIRECTORY

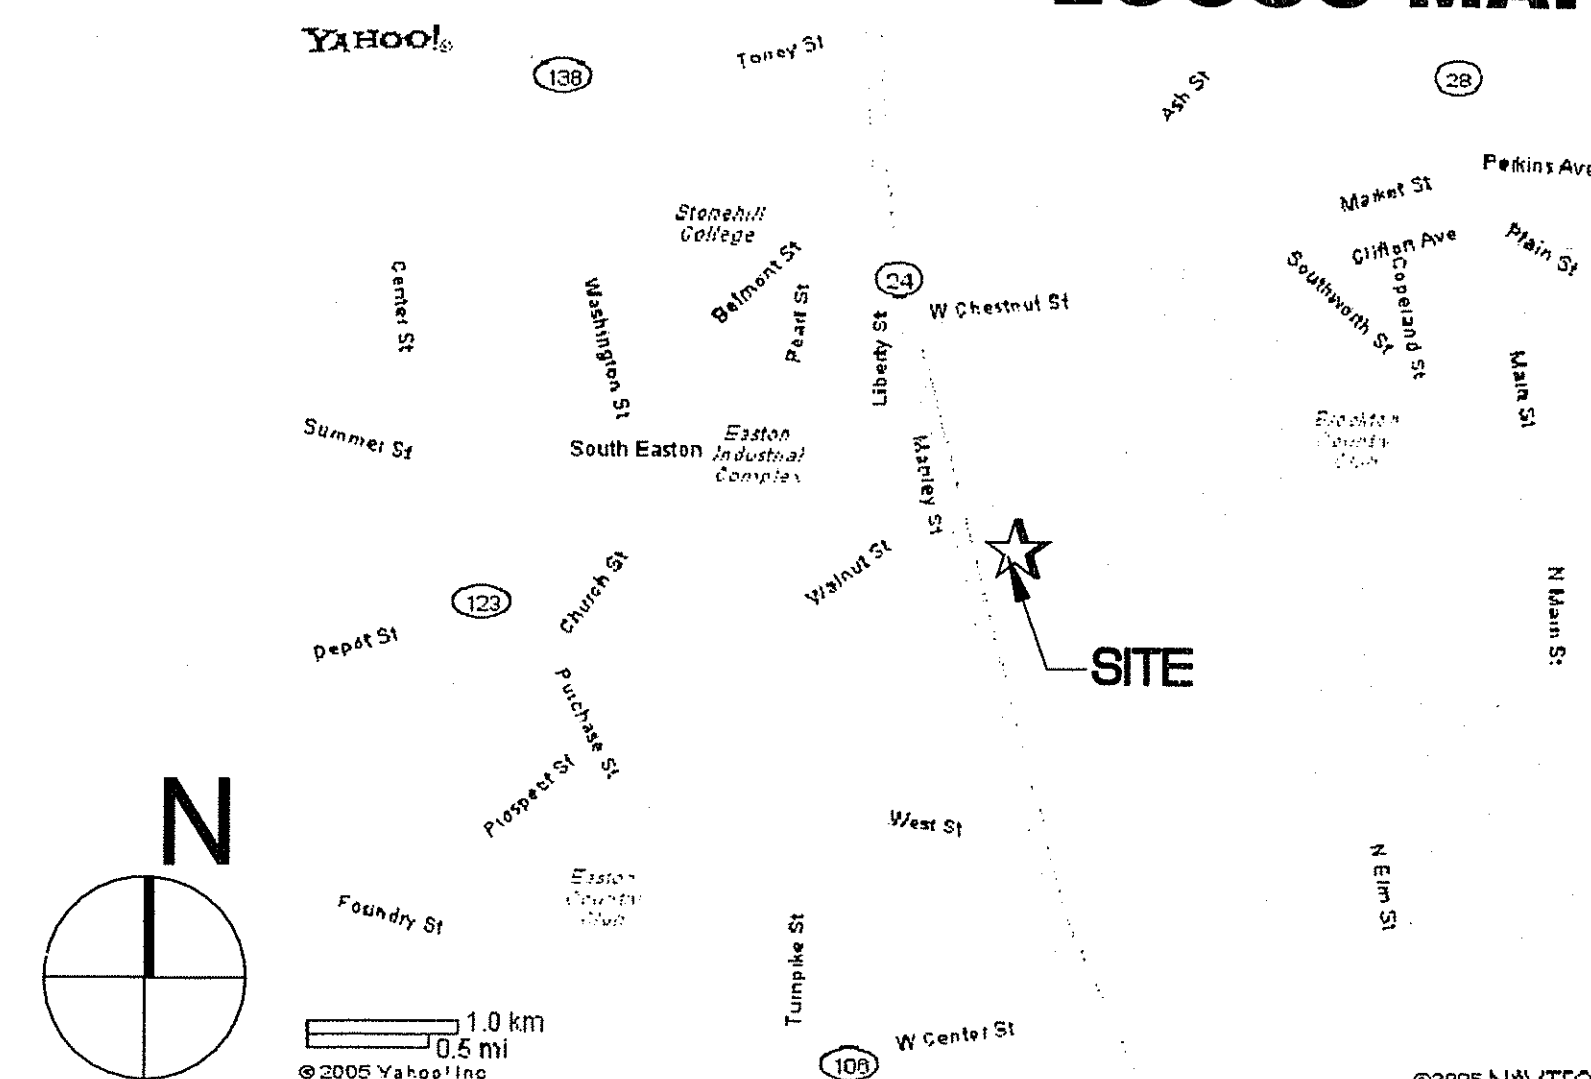
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Stone Forge Restaurant	
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LIST OF DRAWINGS

ARCHITECTURAL:	T01 - LIST OF DRAWINGS, DESIGN/BUILD NOTES & GENERAL NOTES
	T02 - BUILDING CODE REVIEW
	D11 - DEMOLITION PLAN AND NOTES
	A11 - FLOOR PLAN, PARTITION TYPES, & DOOR SCHEDULE
	A21 - REFLECTED CEILING PLAN
	A31 - ENLARGED FLOOR PLAN @ COMMISSARY
	A32 - ENLARGER TOILET ROOM PLANS AND ELEVATIONS
	A33 - ENLARGED RAMP AND STAIR DETAILS
	A41 - DOOR SCHEDULE AND FINISH NOTES
KITCHEN EQUIPMENT:	K12 - FLOOR PLAN
	K11 - EQUIPMENT SCHEDULE
	K12 - PLUMBING ROUGH-IN
	K13 - ELECTRICAL ROUGH-IN

LOCUS MAP



SYMBOL LEGEND

[Symbol]	NEW WALL CONSTRUCTION. SEE ALL FOR PARTITION TYPE SCHEDULE	[Symbol]	DETAIL SYMBOL: DETAIL NO./SHEET NO.
[Symbol]	NEW DOOR AND FRAME. SEE SHEET A81 FOR DOOR SCHEDULE AND INFORMATION	[Symbol]	ELEVATION SYMBOL: ELEVATION/SHEET NO.
[Symbol]	ELEVATION TAG/ EXISTING FLOOR ELEV.	[Symbol]	WALL SECTION MARK: SECTION NO./SHEET NO.
[Symbol]	EXISTING WALL CONSTRUCTION TO REMAIN	[Symbol]	BUILDING SECTION MARK: SECTION NO./SHEET NO.
[Symbol]	PATCH & REPAIR OR INFILL AS OCCURS		

THE BUILDING SHALL BE IN COMPLIANCE WITH THE FOLLOWING:

MASS. STATE BUILDING CODE 6TH EDITION & AMENDMENTS - 180CMR
1996 BOARD OF FIRE PREVENTION REGULATIONS, 521 CMR, LATEST ED.
1995 THE BOCA NATIONAL MECHANICAL CODE
1996 THE MASS FUEL & GAS PLUMBING CODE, AS AMENDED.
SEE NFPA 54 '02 ED.
1996 National Electric Code; MASS. ELEC. CODE 521 CMR 12.00, AS AMENDED
1997 NFPA Life Safety Code 101-94, WHERE REQUIRED DIRECTLY BY MSBC
1992 ADA ACCESSIBILITY GUIDELINES, WHERE APPLICABLE
1996 AAB: ARCHITECTURAL ACCESS BOARD; 521 CMR. W/ LATEST REV.

TITLE SHEET: LIST OF DRAWINGS, DESIGN/BUILD NOTES, GENERAL NOTES, ABBREVIATIONS, & SYMBOL LEGEND

NOBLE VENTURES
STONEFORGE COMMISSARY
255 WALNUT STREET
WEST BRIDGEWATER, MASSACHUSETTS

Scale: AS NOTED
Date: 4/15/06
Drawn By: MAP
Checked By: ASB
Job Number: 206019

Drawing:

TS.1

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